



SECTION AA


SCALE 1:100

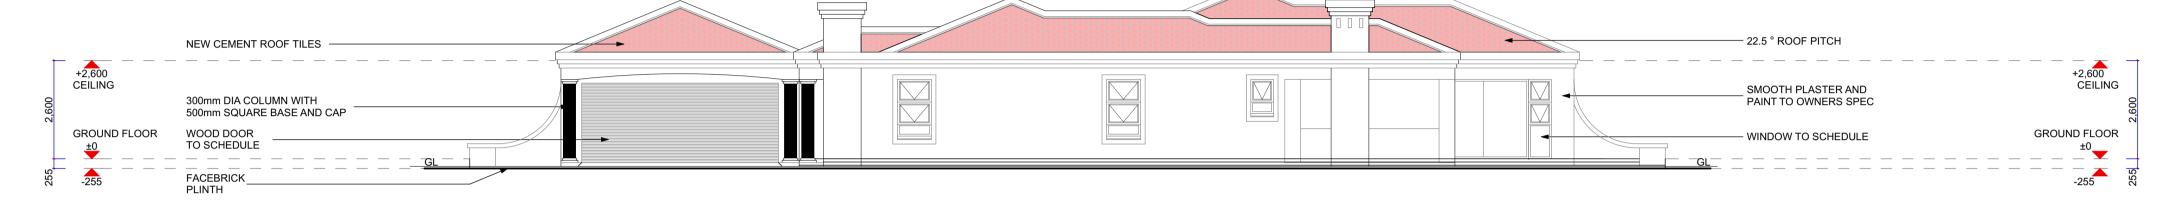


SOUTH ELEVATION

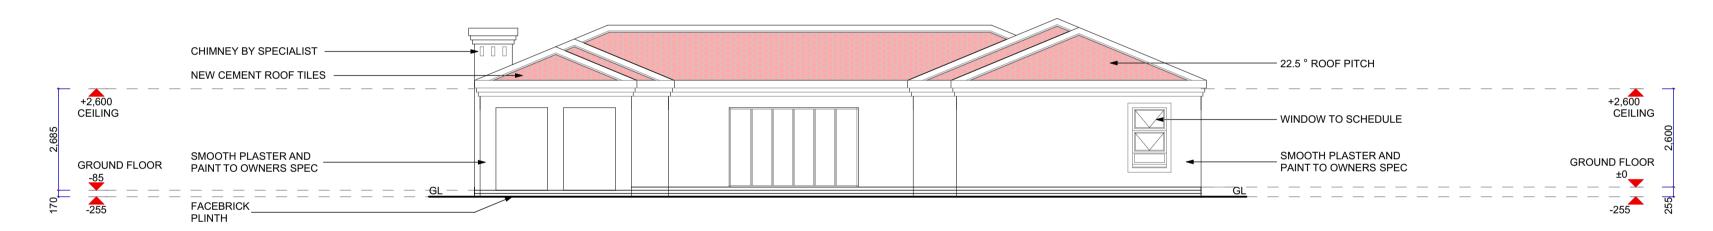

EAST ELEVATION SCALE 1:100

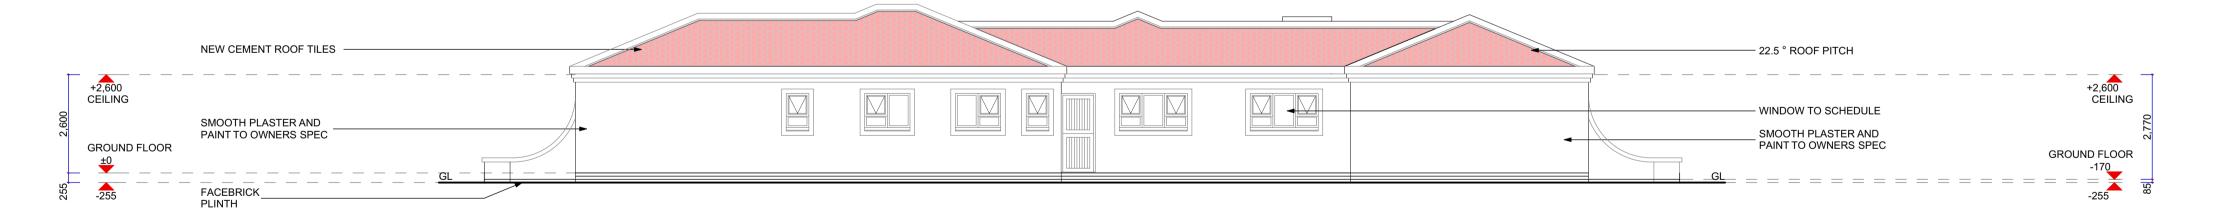

NORTH ELEVATION

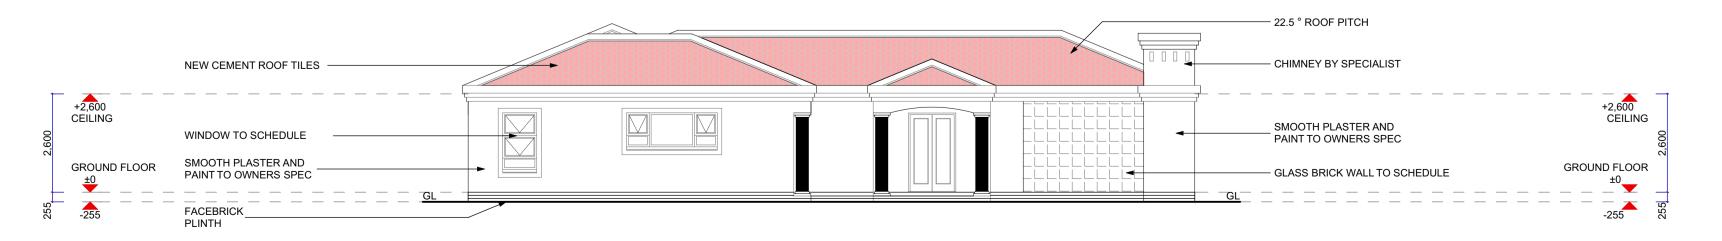

WEST ELEVATION

ARCHTECTS NOTES

- Dimensions to be used in preference to scaling.
 Any discrepancies on drawings to be pointed out by the contractor prior to the implementation there off.
- 3. All dimensions to be checked on site prior to commencement of work.
 4. Plumbing contractor to liaise with architect prior to changing any
- 5. All building work must comply to municipal and S.A.B.S. 10400

standards. GENERAL NOTES 1. All work to comply with municipal bylaws and regulations s.a.b.s

- 10400-1990
- 2. All structural works to be carried out to structural engineers specification 3. Any ommissions, dimensions or errors to be reported to the architect
- ROOF NOTES
 1. Concrete cement tiles on 38x38 battens @ 320 crs, on PDC underlay, on 114x38 rafters @ 760 crs, on 114x38 wall plate with sisalation (according to SANS Part XA). All trusses to manufacturers
- specification @ min 17.5 deg pitch

 2. Sheeting roof on Sisalation (according to SANS Part XA) @ 1500 crs, on

rafters to manufacturers spec @ min 5 deg pitch **DRAINAGE NOTES** 1. All sewer and drainage reticulation to be in accordance to municipal

- 2. All sewerage to comply with closed sewers system to NBRI standards u
- 3. Drainage shown is schematic and purely for directional purposes.
- 4. ASVP to any fitting or appliance that has a vertical drop in excess of
- 5. Stub stacks and cleaning eye at all fittings with overflow gully at lowest
- point
 6. All bends to be long radius and fitted with inspection eye MECHANICAL AND ELECTRICAL NOTES
- 1. All work to comply with municipal byelaws and regulations and s.a.b.s 2. All work to comply with the civil engineers design and specifications
- STORM WATER NOTES 1. Storm water layout to be done in accordance to local municipal By-Laws
- 2. All work to comply with the civil engineers design and specifications. **WALL NOTES**
- 1. 110mm & 220mm SABS approved brick wall's with brick force every third
- course. Pre-Stressed lintols over all openings.

 2. DPC to all walls at floor level and under all window cills
- Vertical dpc to any changes in floor level, dpc to s.a.b.s 298
 All brickwork in foundations and plinth up to floor level- to be 220mm SABS approved bricks only
- ENERGY EFFICIENCY NOTE 1. The installation, mantenance, repair and replacement of domestic solar
- water heating systems and thermal insulation to be in accordance with part XA SANS 10106 2. Fenestration (Glazing) to be in accordance with part XA SANS 10106

Municipal Stamps

DRAWN BY: MAX MAPIYE

CHECKED BY: EMMANUEL NDLOVU

OWNERS SIGNATURE

DESIGNERS SIGNATURE

EX Design and Construction (PTY) Ltd Mr. E. X. Ndlovu - Pr. Techni Eng.

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ex design "disrupt the normal"

SECTIONS & ELEVATIONS

PROPOSED NEW HOUSE FOR MR **NXUMALO** ON LOT 7321 No 6A SEEPERDJIE

Project Number Drawing Number Category 1 Building 200-400 LOT 7321 H4

MEERENSEE, RICHARDS BAY